

Notes:

- Proposed grades shown within the anchor trench represent top of sand base grades. Proposed grades shown outside the anchor trench represent final grades.
- Plant tree species native to the site wetlands on the pond bottoms on a maximum 50-foot center-to-center spacing to shade standing water in the ponds. Tree species shall include northern conifer (spruce, fir) and swamp hardwood (white birch, quaking aspen).
- Refer to Sheets 9, 10, 11, and 12 for additional detail.


Legend

	Existing 2' Contour
	Existing 10' Contour
	Existing Tree Line
	Existing Edge of Gravel
	Existing Perennial Stream
	Existing Intermittent Stream
	Wetland Delineation Limit
	Proposed 1' Contour
	Proposed 5' Contour
	Proposed Anchor Trench
	Proposed Erosion Control (Compost Sock, Silt Fence, ECM Berm)
	Proposed Guardrail
	Proposed Wall
	Proposed Treeline
	Proposed Litter Fence
	Proposed Gas Line
	Proposed Forcemain
	Proposed Overhead Electric
	Proposed Sewer
	Proposed Pavement Road
	Proposed Gravel Road
	Permanent Wetland Impacts
	Temporary Wetland Impacts

Plan Notes:

Detail references refer to the detail sheets included in the Granite State Landfill Permitting Plan Set dated October 2023.

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date: January 2024	designed by: ATR/UM/STF/AJS
project no: 1101	drawn by: ATR/UM/STF
checked by: AJS	approved by: AJS
scale: as shown	
Granite State Landfill, LLC Dalton, New Hampshire Permitting Plan Set	
Grading & Drainage Plans Index Sheet	
drawing no. Index	
sheet: 1	of 12

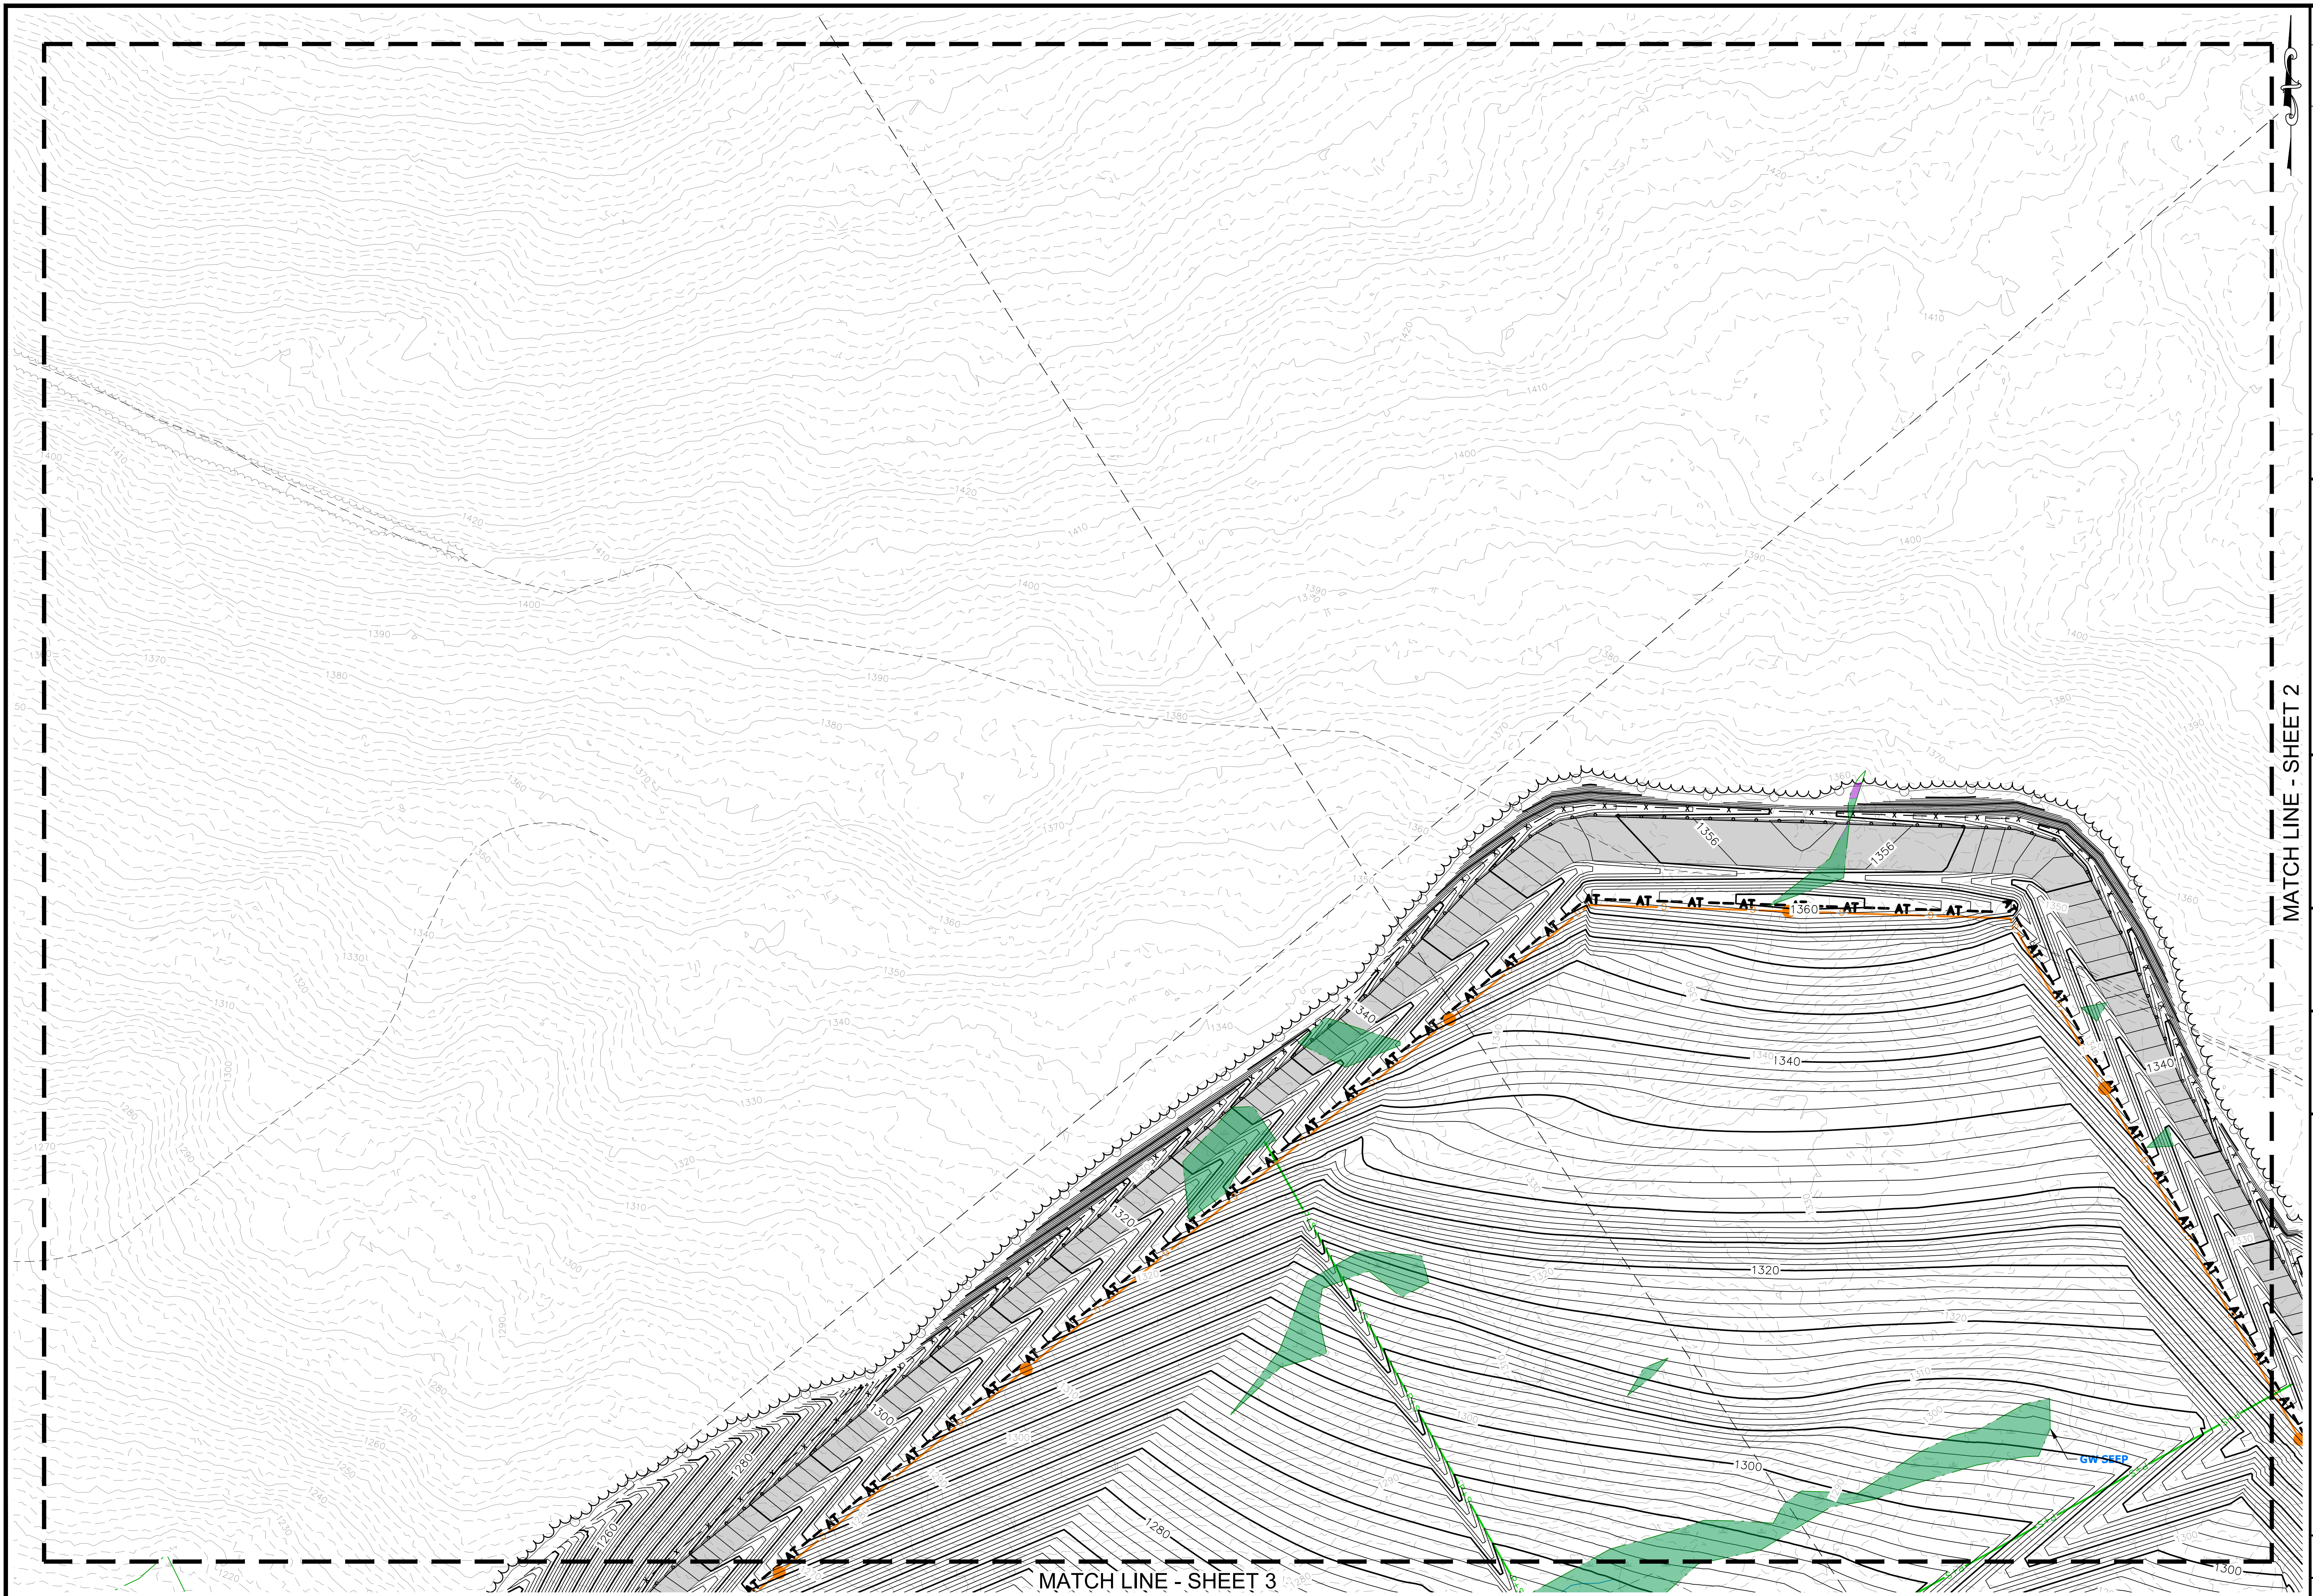

MATCH LINE - SHEET 2

<p>date: January 2024</p> <p>project no: 1101</p> <p>checked by: AJS</p>	<p>designed by: ATR/UM/STF/AJS</p> <p>drawn by: ATR/UM/STF</p> <p>approved by: AJS</p>	<p>scale: 1" = 50'</p> <p>0 50' 100'</p>	<p>no. _____</p> <p>revision _____</p> <p>date _____</p> <p>by _____</p>
<p>Granite State Landfill, LLC Dalton, New Hampshire</p>		<p>Permitting Plan Set Grading & Drainage Plans Sheet 1</p>	
<p>drawing no. Sheet 1</p>		<p>sheet: 2 of 12</p>	

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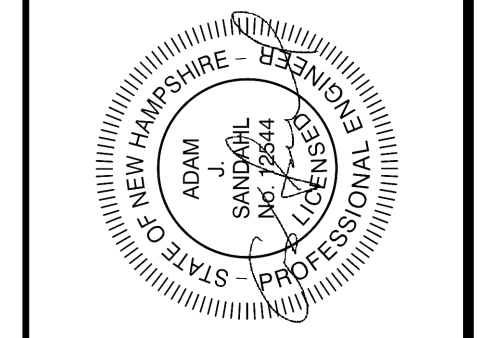


MATCH LINE - SHEET 1

MATCH LINE - SHEET 4

<p>Granite State Landfill, LLC Dalton, New Hampshire</p>		<p>date: January 2024 project no: 1101 checked by: AJS</p>	<p>designed by: ATR/JM/MSTF/AJS drawn by: ATR/JM/MSTF approved by: AJS</p>	<p>scale: 0 50' 100' Scale: 1" = 50'</p>
<p>Permitting Plan Set</p>		<p>drawing no. Sheet 2</p>		
<p>Grading & Drainage Plans Sheet 2</p>		<p>no. revision date by</p>		

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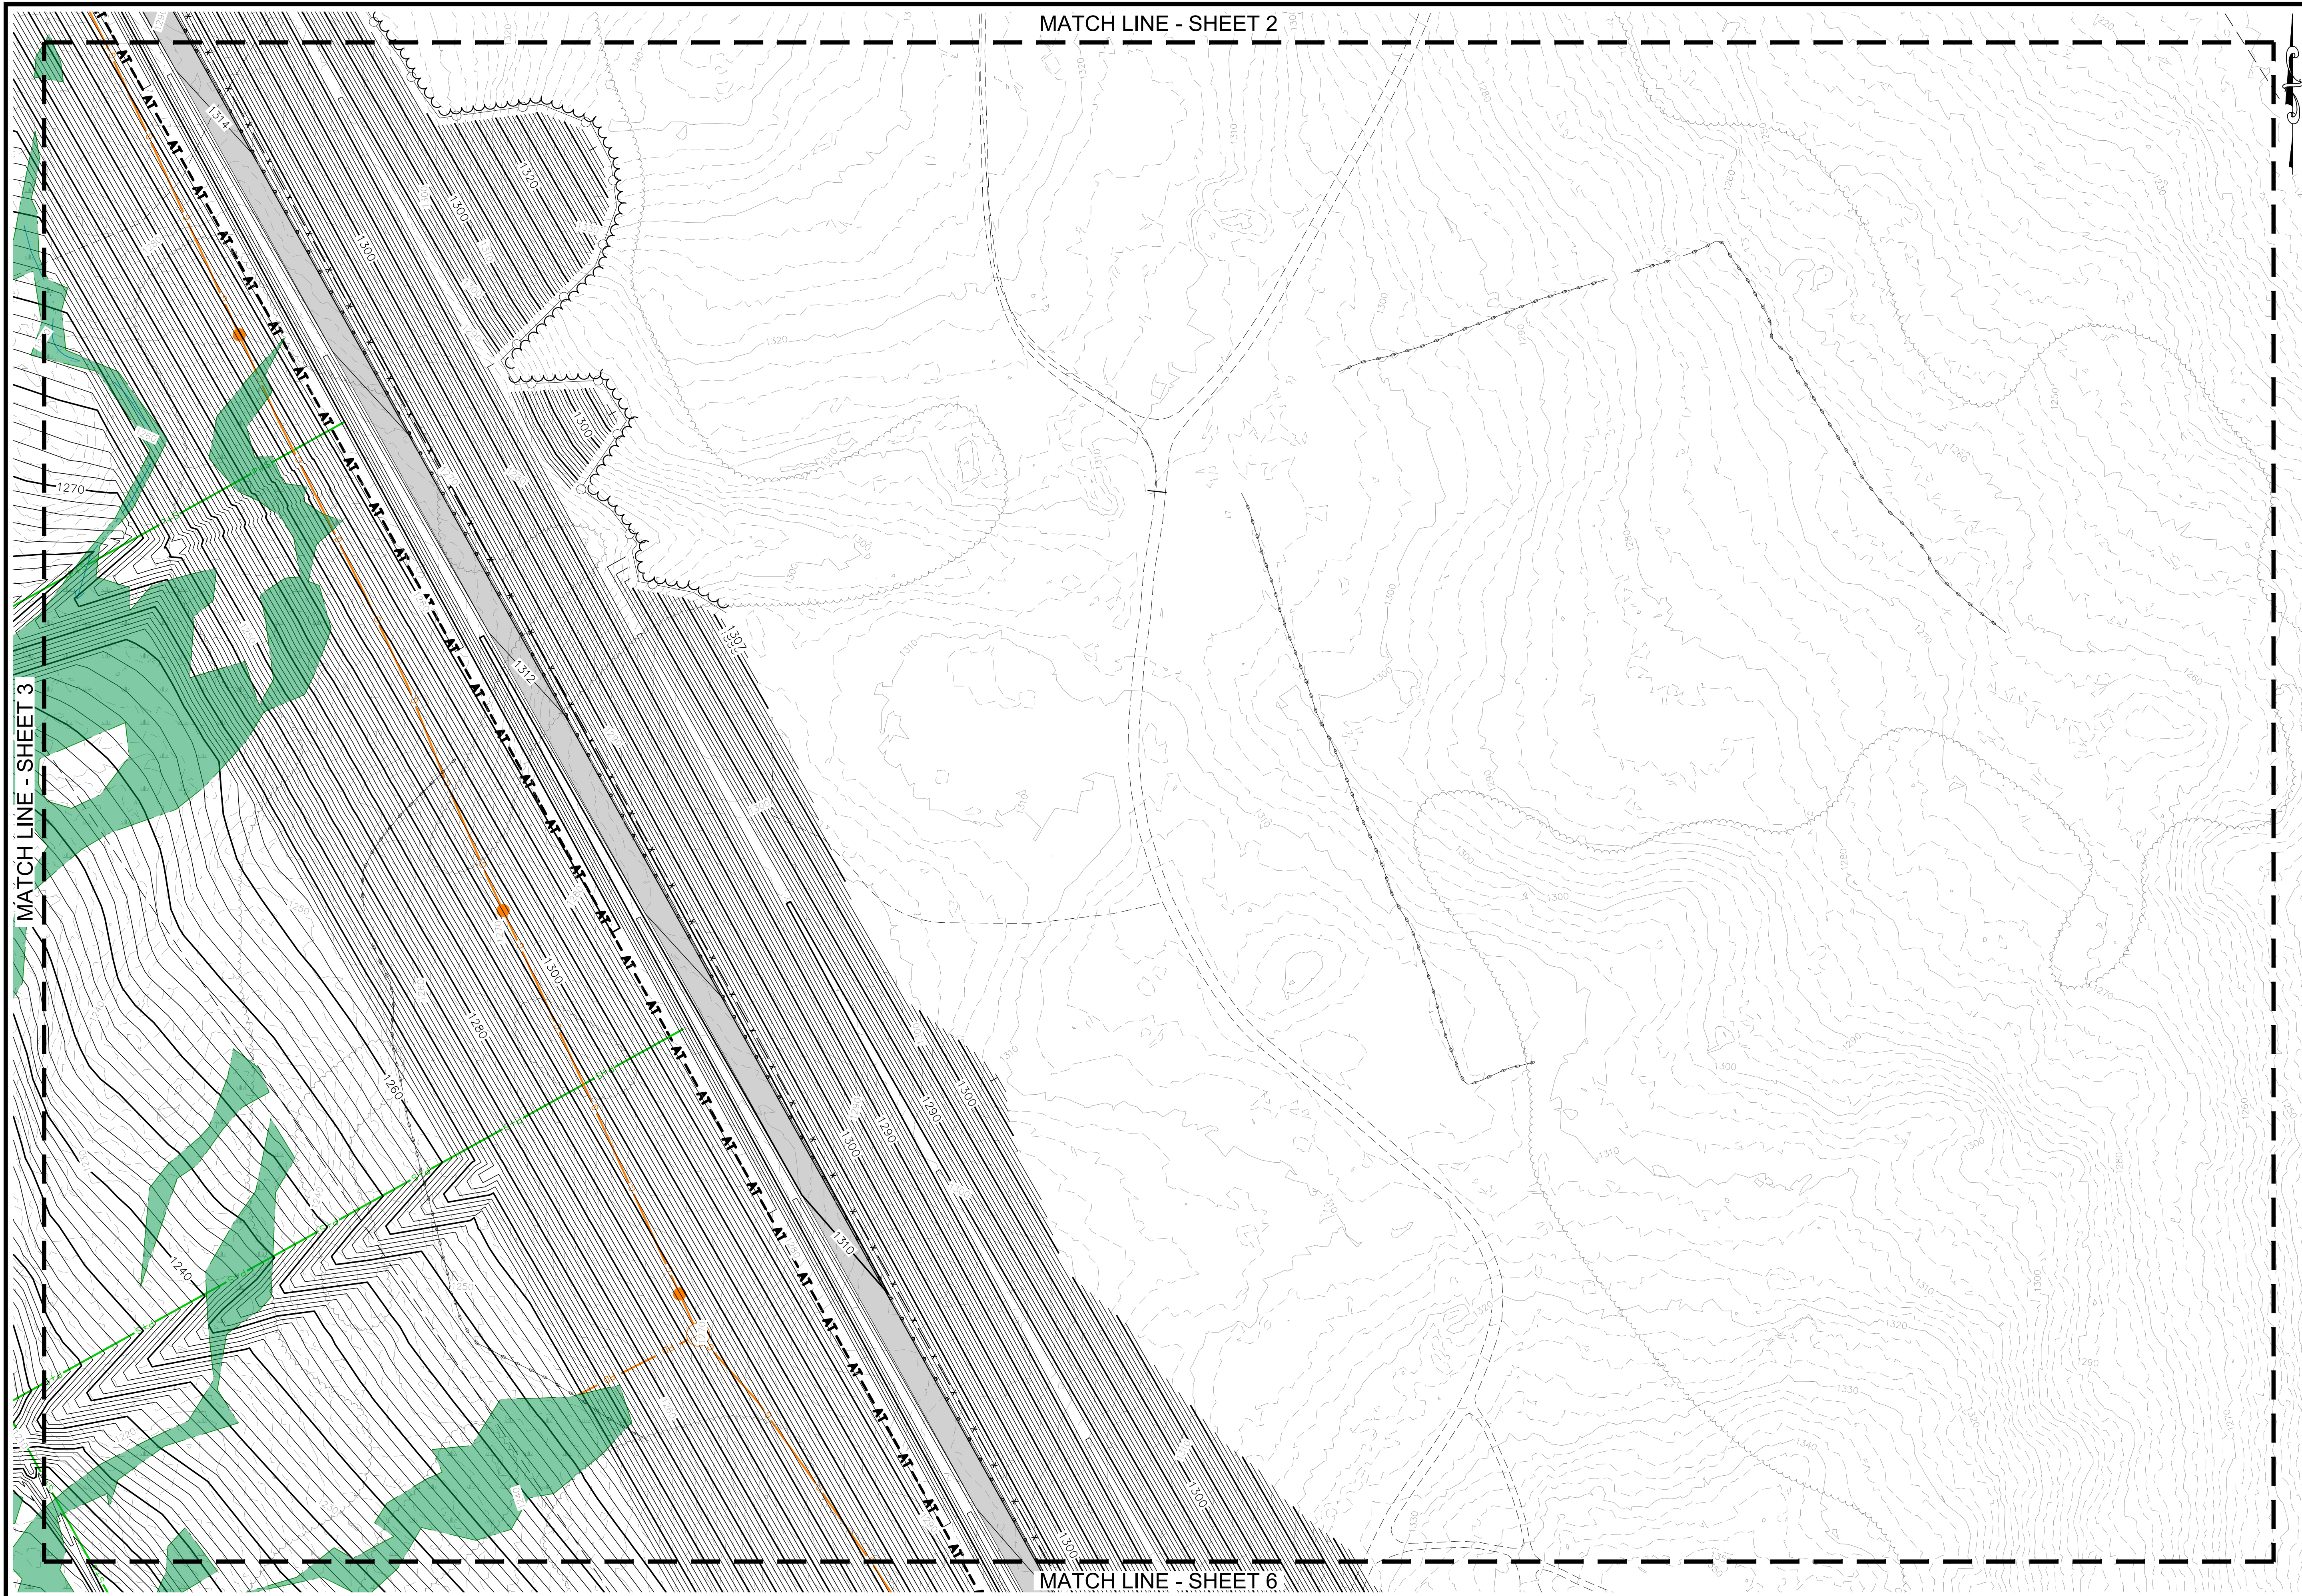


MATCH LINE - SHEET 1

MATCH LINE - SHEET 4

MATCH LINE - SHEET 5

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<p>designed by: ATR/JM/SSTF/AJS</p>	<p>drawn by: ATR/JM/SSTF</p>	<p>approved by: AJS</p>
<p>date: January 2024</p>	<p>project no: 1101</p>	<p>checked by: AJS</p>
<p>Scale: 1" = 50'</p> <p>0 50' 100'</p>		
<p>Granite State Landfill, LLC Dalton, New Hampshire</p>		
<p>Permitting Plan Set</p>		
<p>Grading & Drainage Plans</p>		
<p>Sheet 3</p>		
<p>drawing no. _____</p>		
<p>sheet: 4 of 12</p>		




MATCH LINE - SHEET 2

MATCH LINE - SHEET 6

MATCH LINE - SHEET 3

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<p>date: January 2024</p>	<p>designed by: ATR/NUMSTF/AJS</p>
<p>project no: 1101</p>	<p>drawn by: ATR/NUMSTF</p>
<p>checked by: AJS</p>	<p>approved by: AJS</p>
<p>scale: 0 50' 100' Scale: 1" = 50'</p>	
<p>Granite State Landfill, LLC Dalton, New Hampshire Permitting Plan Set</p>	
<p>Grading & Drainage Plans Sheet 4</p>	
<p>drawing no: Sheet 4</p>	
<p>sheet: 5 of 12</p>	

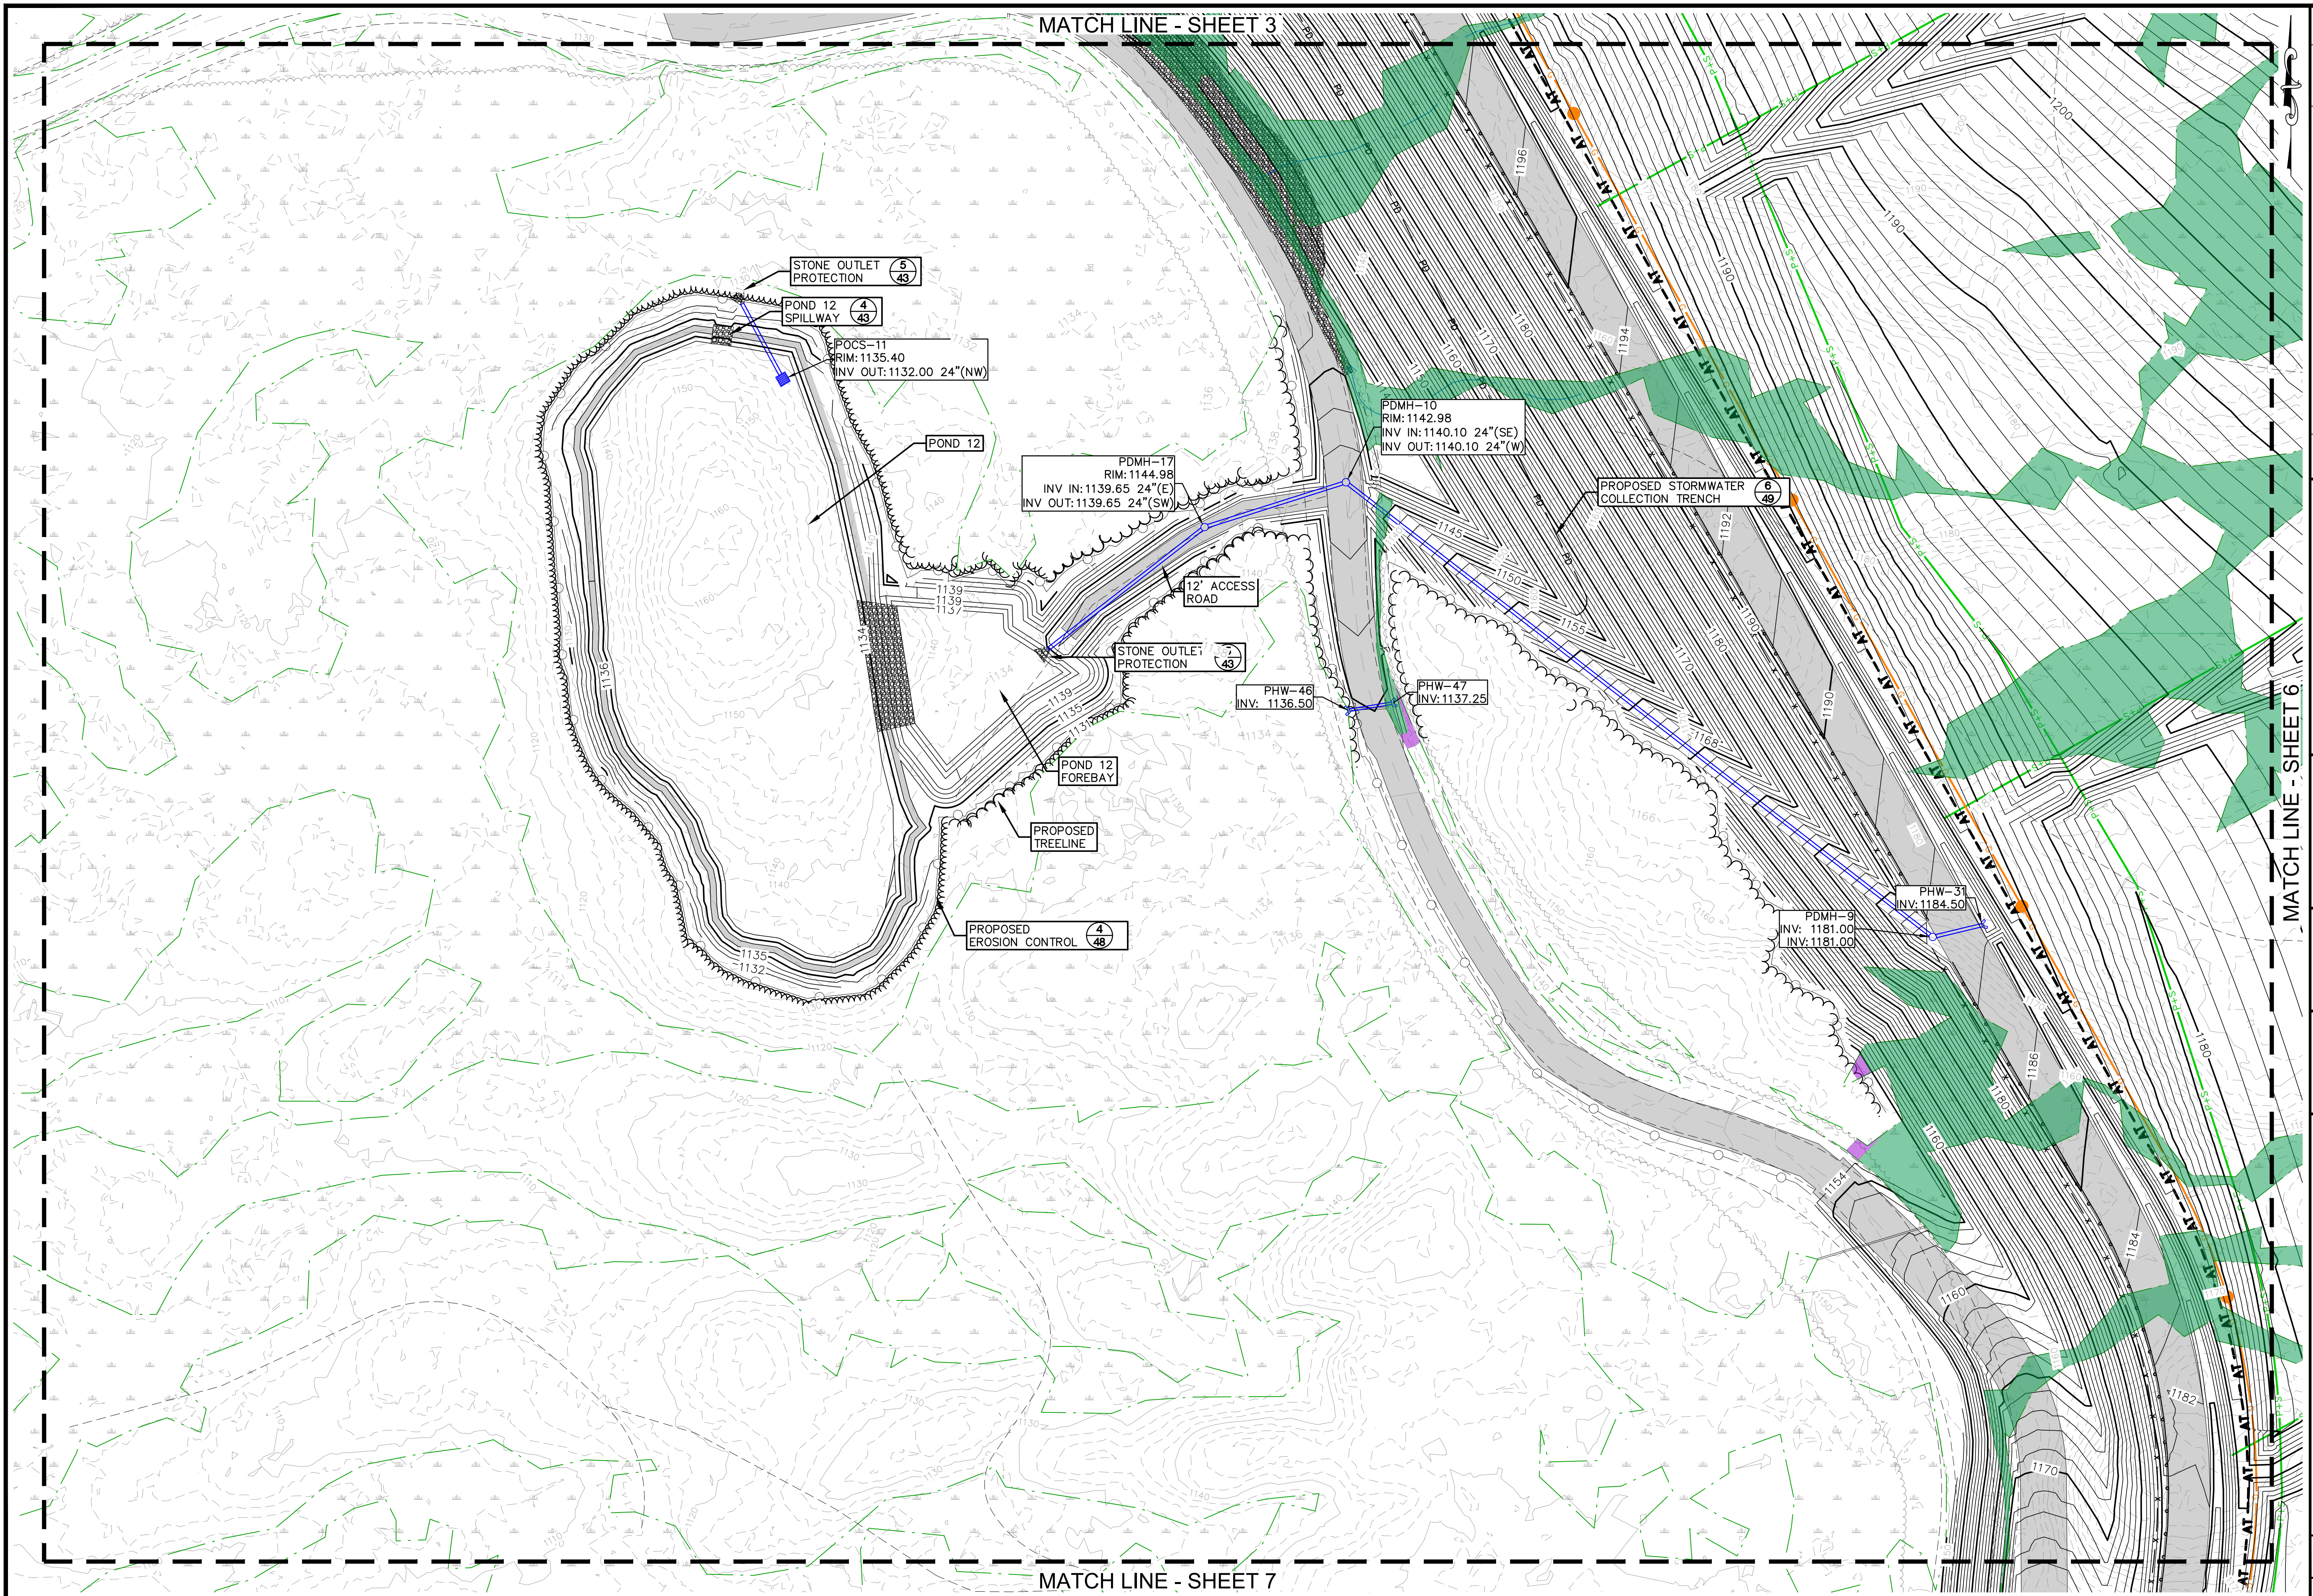


MATCH LINE - SHEET 3

MATCH LINE - SHEET 7

MATCH LINE - SHEET 6

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<p>date: January 2024 project no: 1101</p>		<p>drawing no: Sheet 5</p>
<p>Granite State Landfill, LLC Dalton, New Hampshire Permitting Plan Set</p>		<p>Grading & Drainage Plans Sheet 5</p>
<p>sheet: 6 of 12</p>		

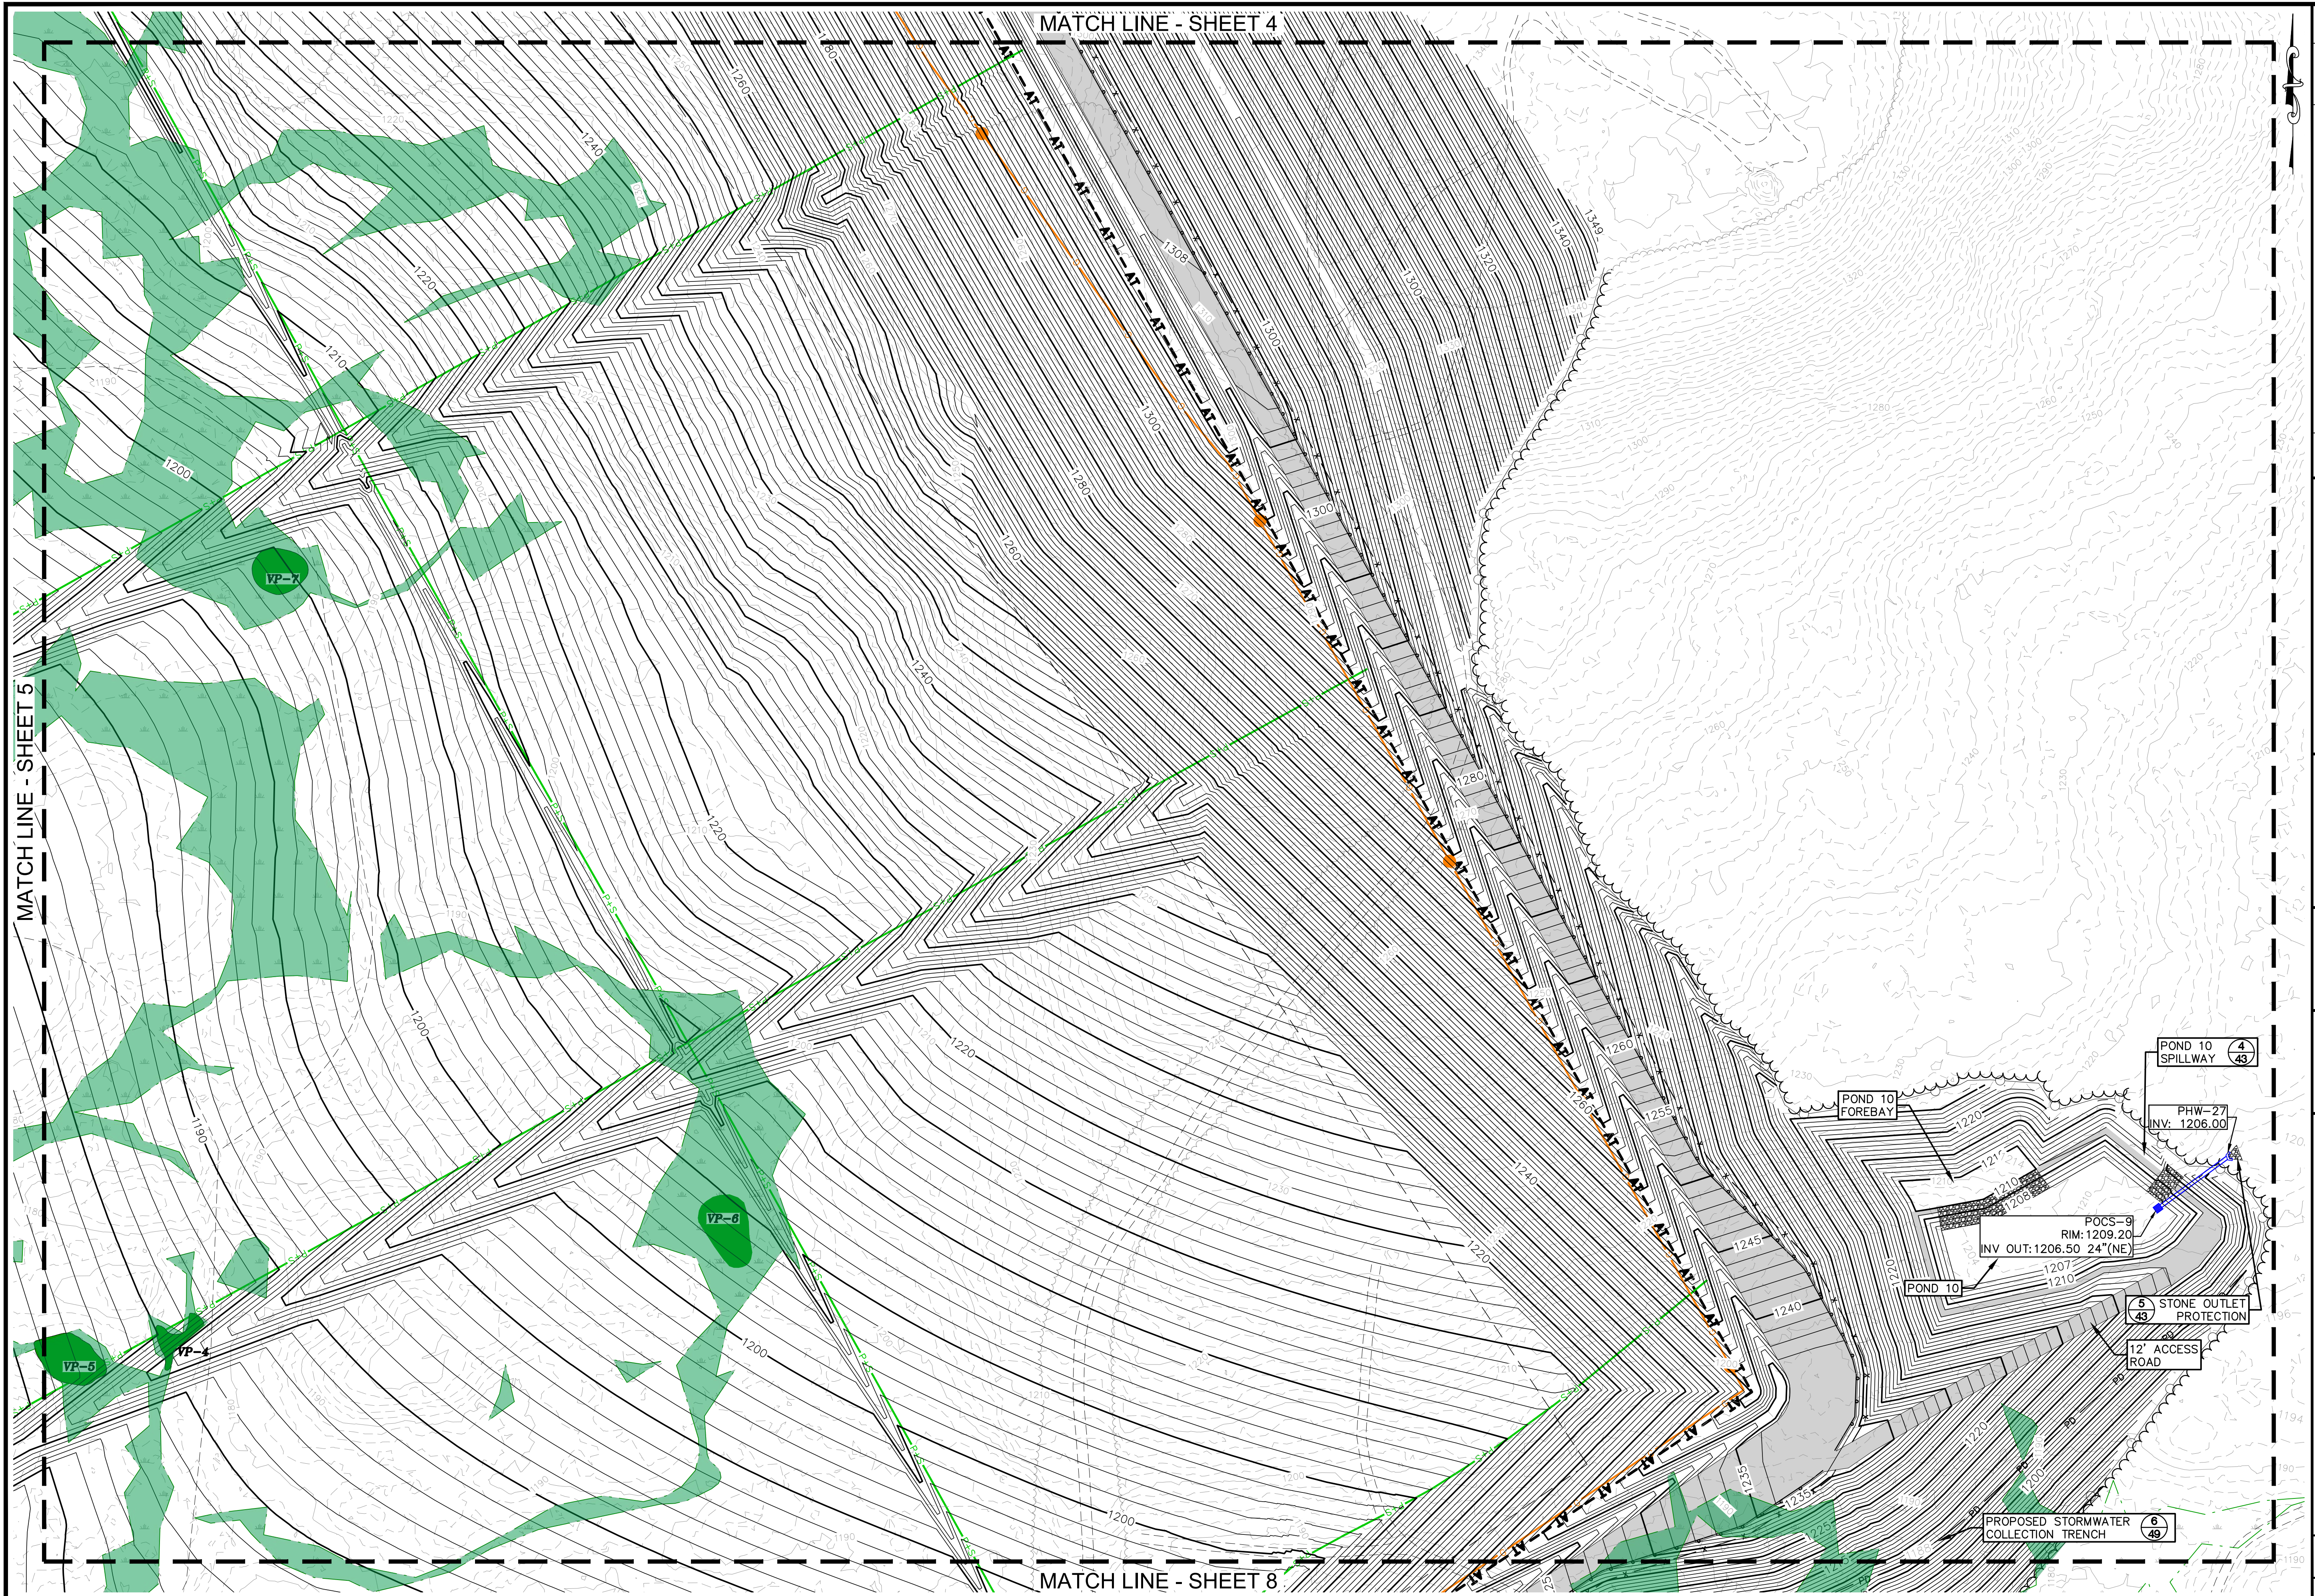

MATCH LINE - SHEET 4


MATCH LINE - SHEET 5

MATCH LINE - SHEET 8

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<p>designed by: ATR/JM/STF/AJS drawn by: ATR/JM/STF checked by: AJS approved by: AJS</p>		<p>scale: 1" = 50' 0 50' 100'</p>
<p>date: January 2024 project no: 1101</p>		<p>drawing no: Sheet 6</p>
<p>Granite State Landfill, LLC Dalton, New Hampshire Permitting Plan Set</p>		<p>Grading & Drainage Plans Sheet 6</p>
<p>sheet: 7 of 12</p>		

MATCH LINE - SHEET 5


MATCH LINE - SHEET 9

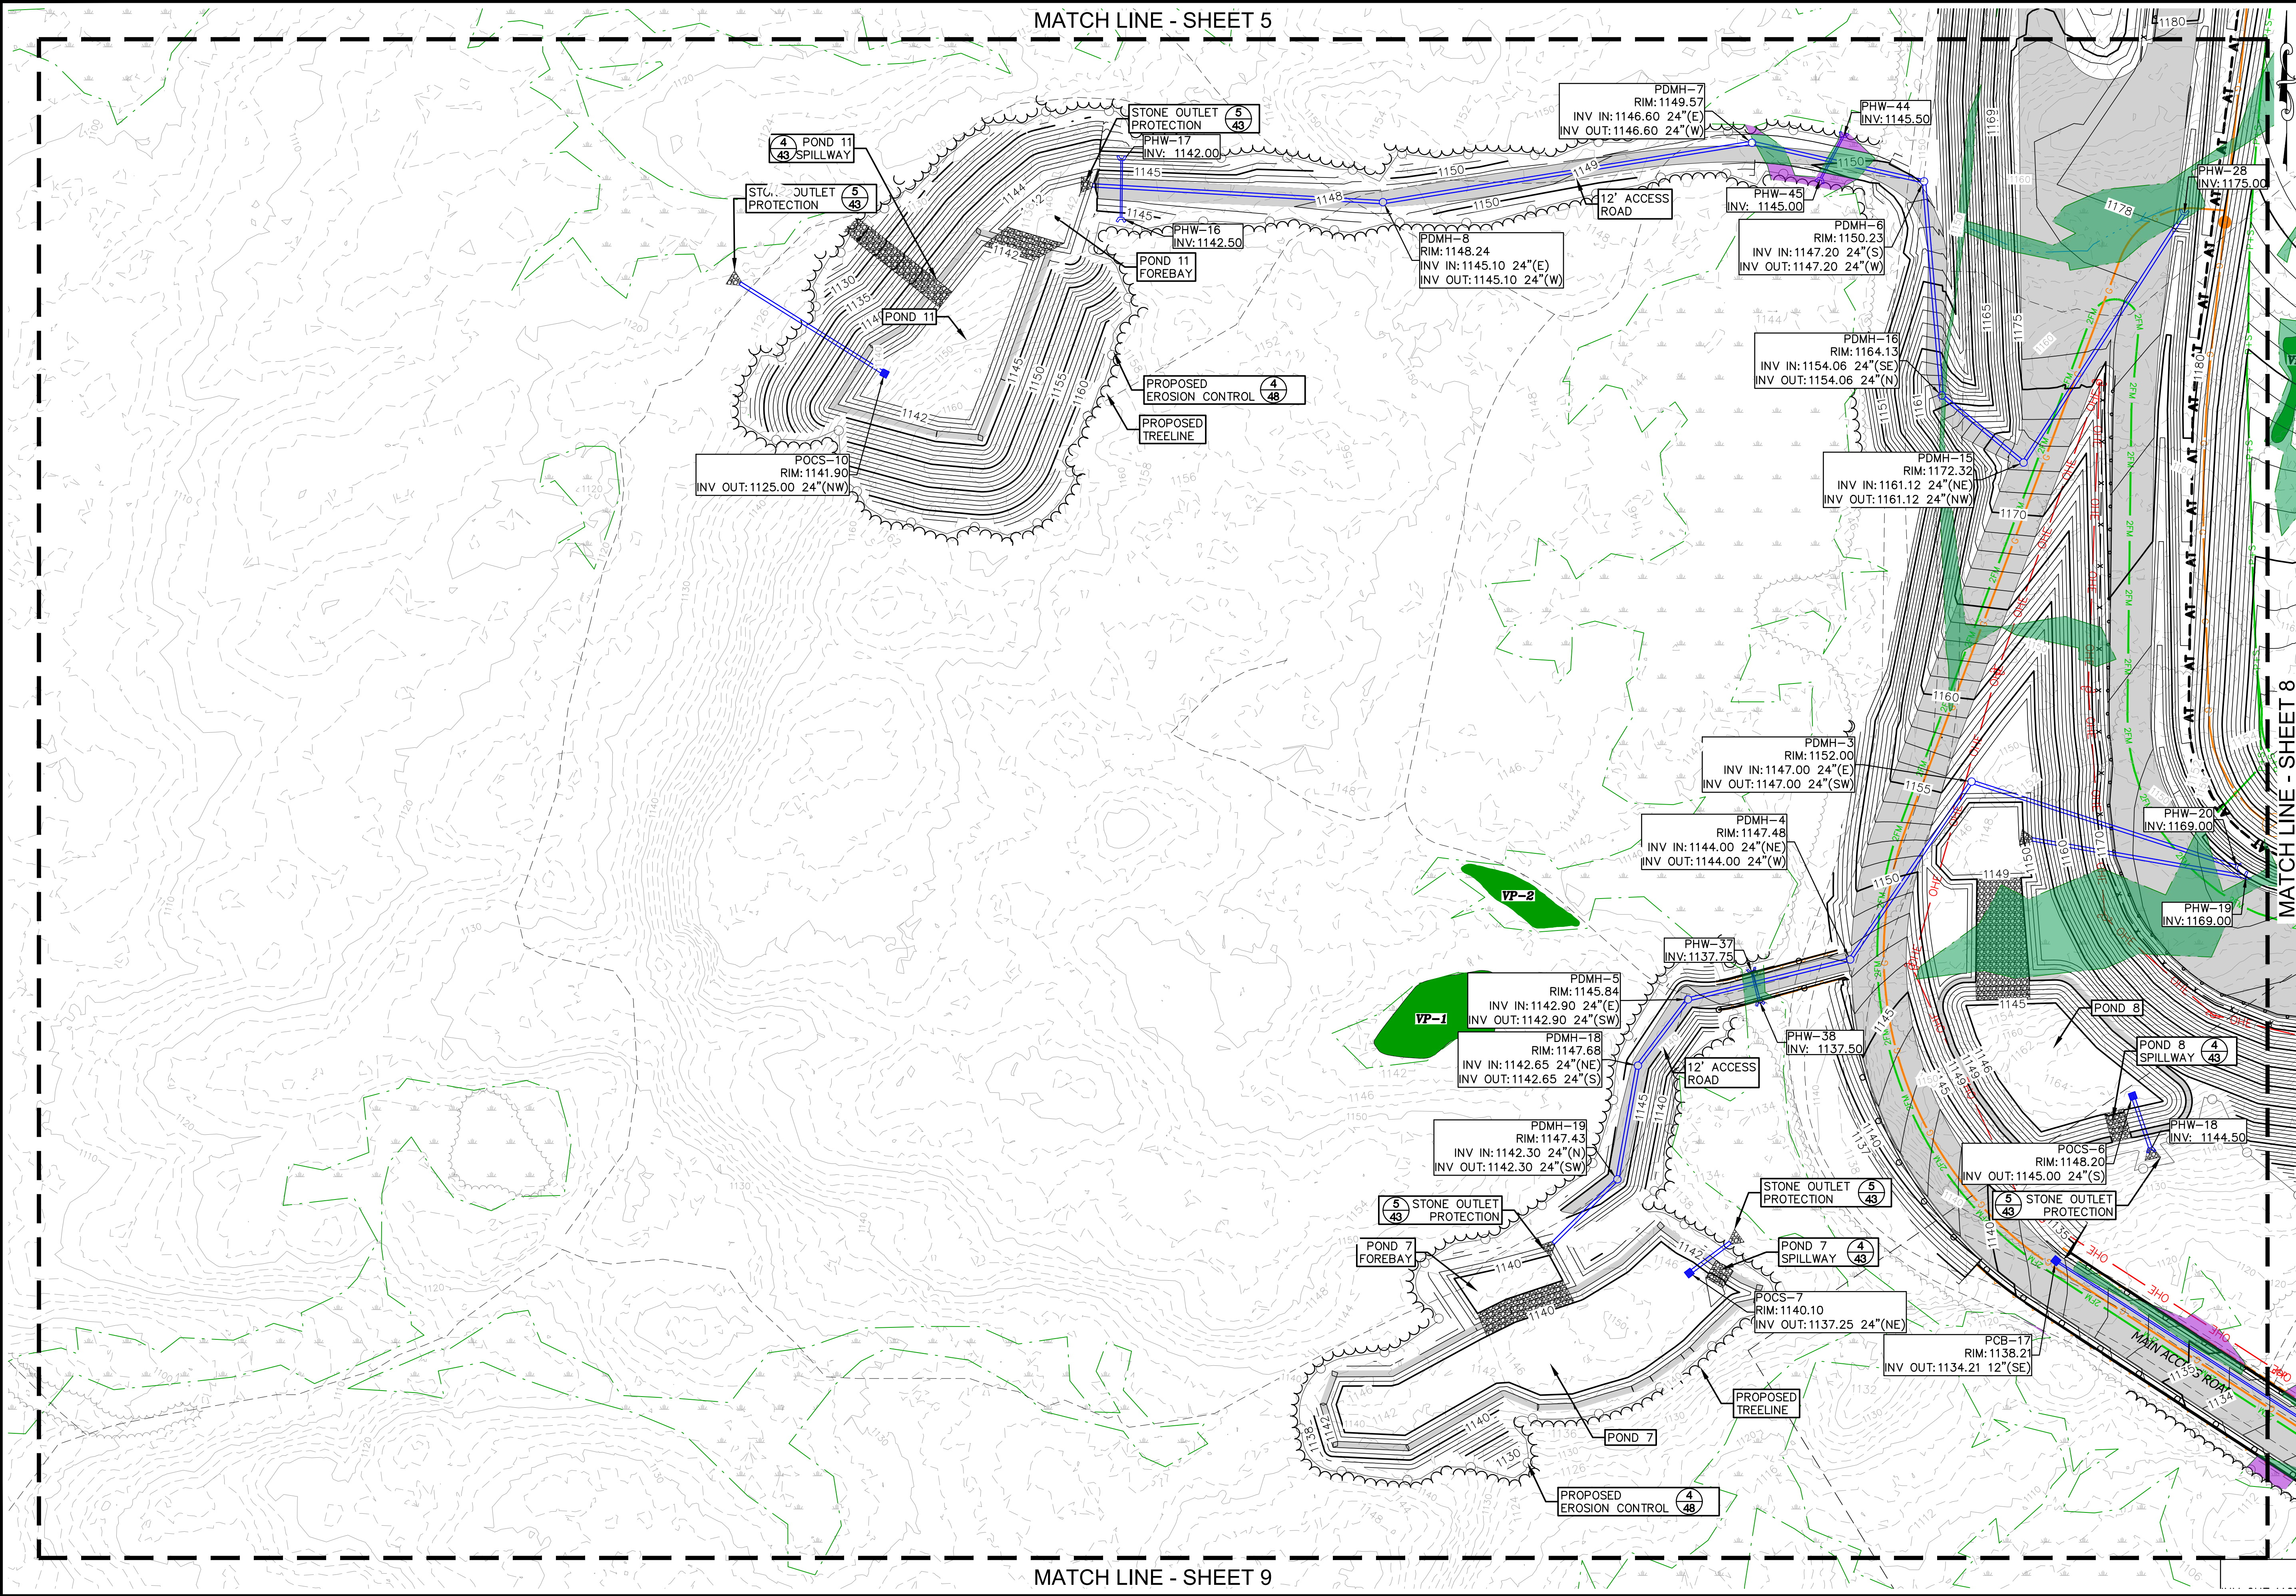

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<p>Granite State Landfill, LLC Dalton, New Hampshire Permitting Plan Set Grading & Drainage Plans Grading and Drainage Plan 4</p>		<p>drawing no: Sheet 7</p> <p>sheet: Sheet 7 of 12</p>		


MATCH LINE - SHEET 7

INV OUT:

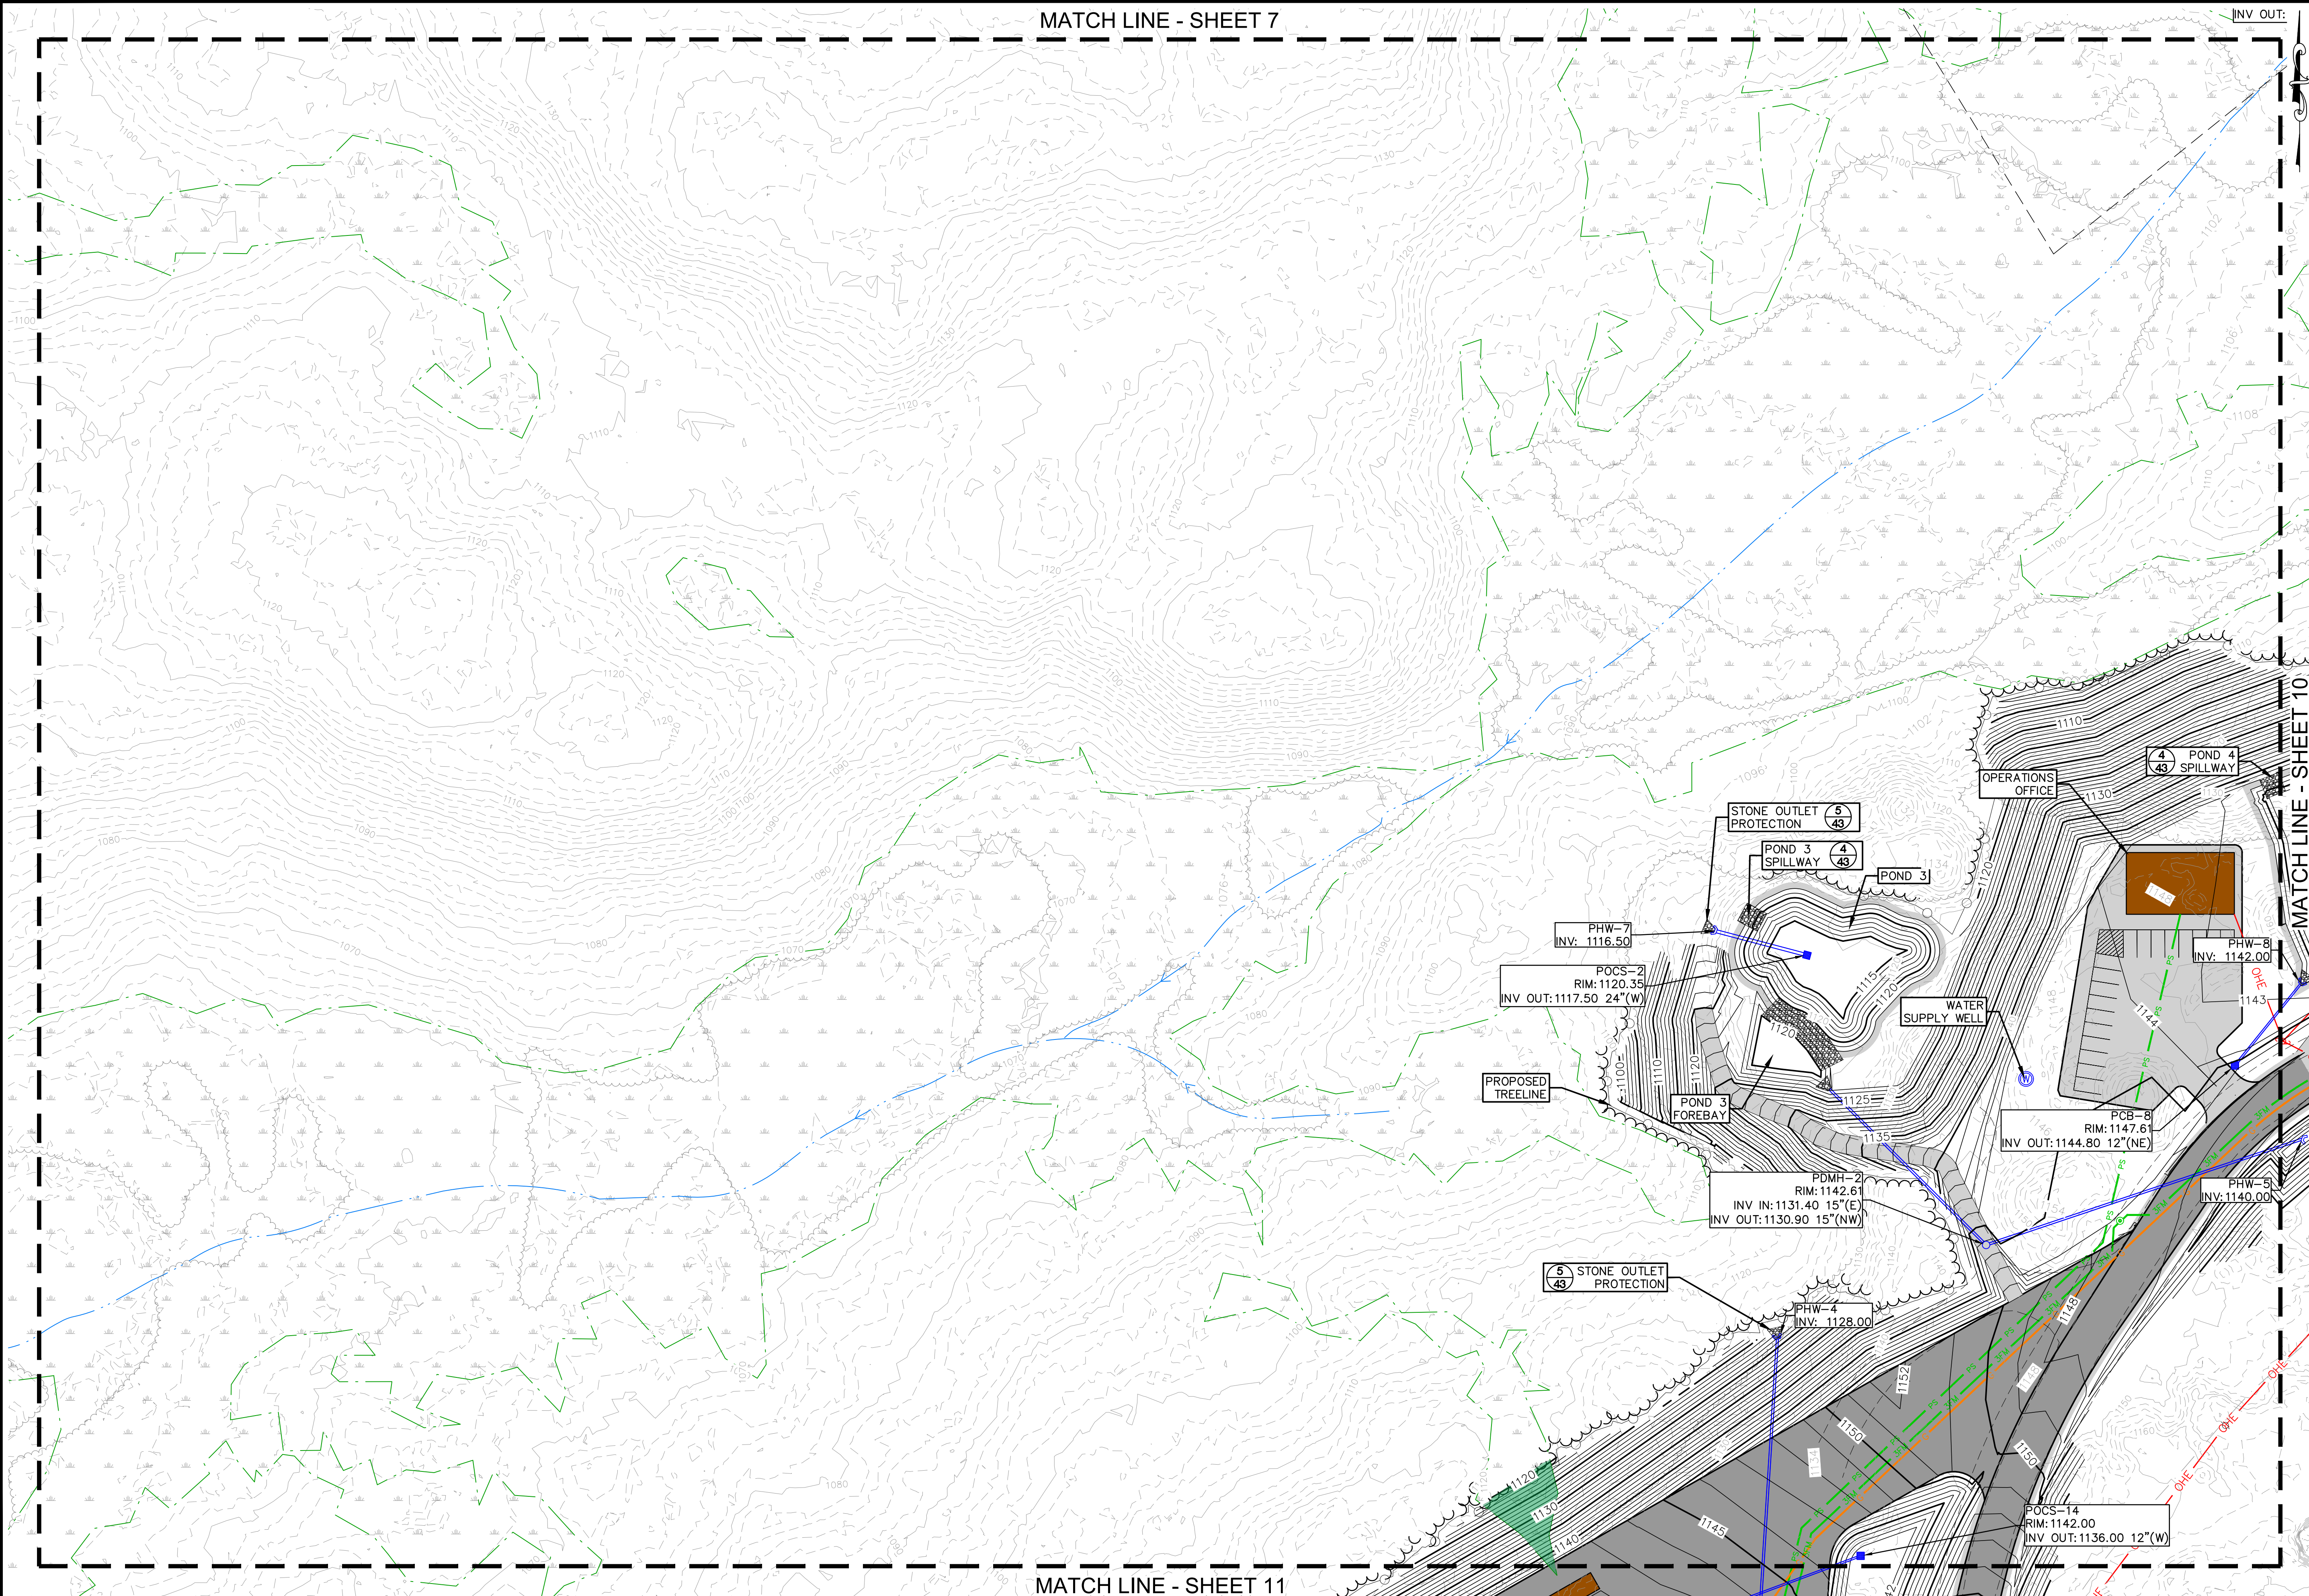


MATCH LINE - SHEET 11


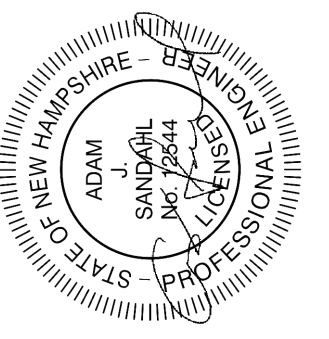
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Granite State Landfill, LLC Dalton, New Hampshire Permitting Plan Set Grading & Drainage Plans Sheet 9		date: January 2024 project no: 1101 drawing no: _____ sheet: 10 of 12

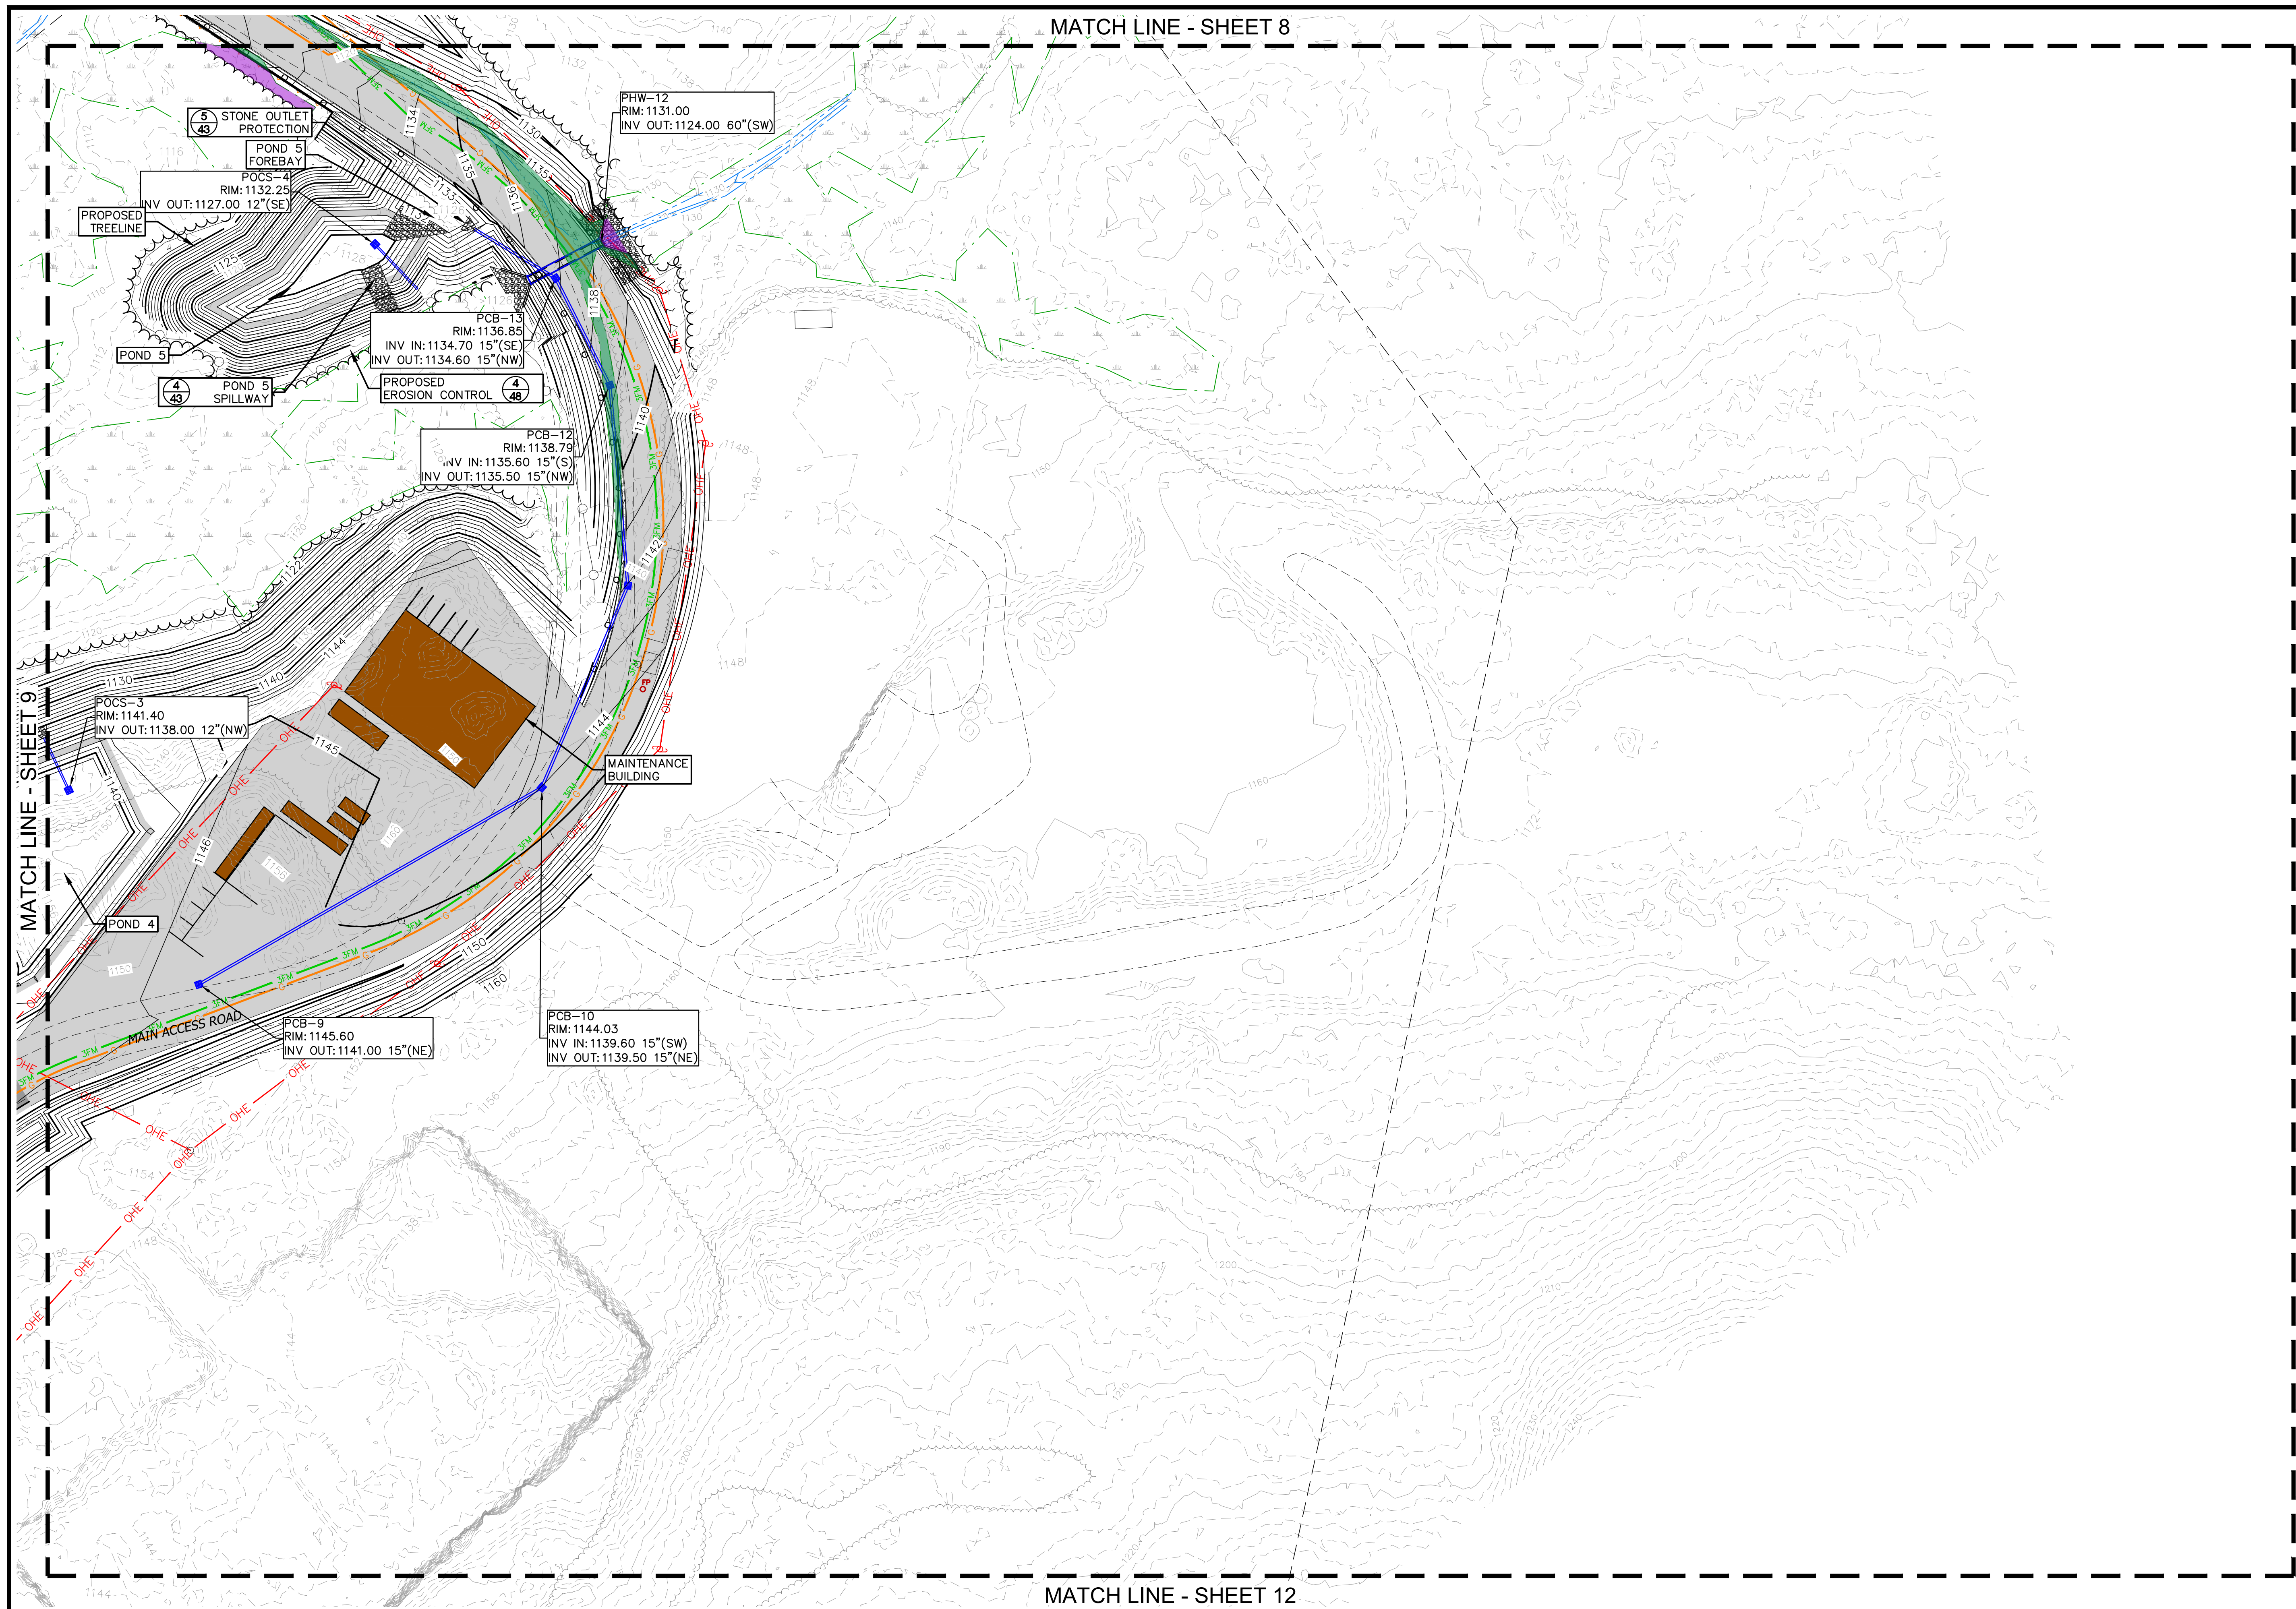

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<p>date: January 2024</p> <p>project no: 1101</p> <p>checked by: AJS</p>		<p>drawing no: Sheet 10</p>		
<p>Granite State Landfill, LLC Dalton, New Hampshire Permitting Plan Set</p>		<p>Grading & Drainage Plans Sheet 10</p>		
<p>sheet: 11 of 12</p>		<p>no. revision date by</p>		

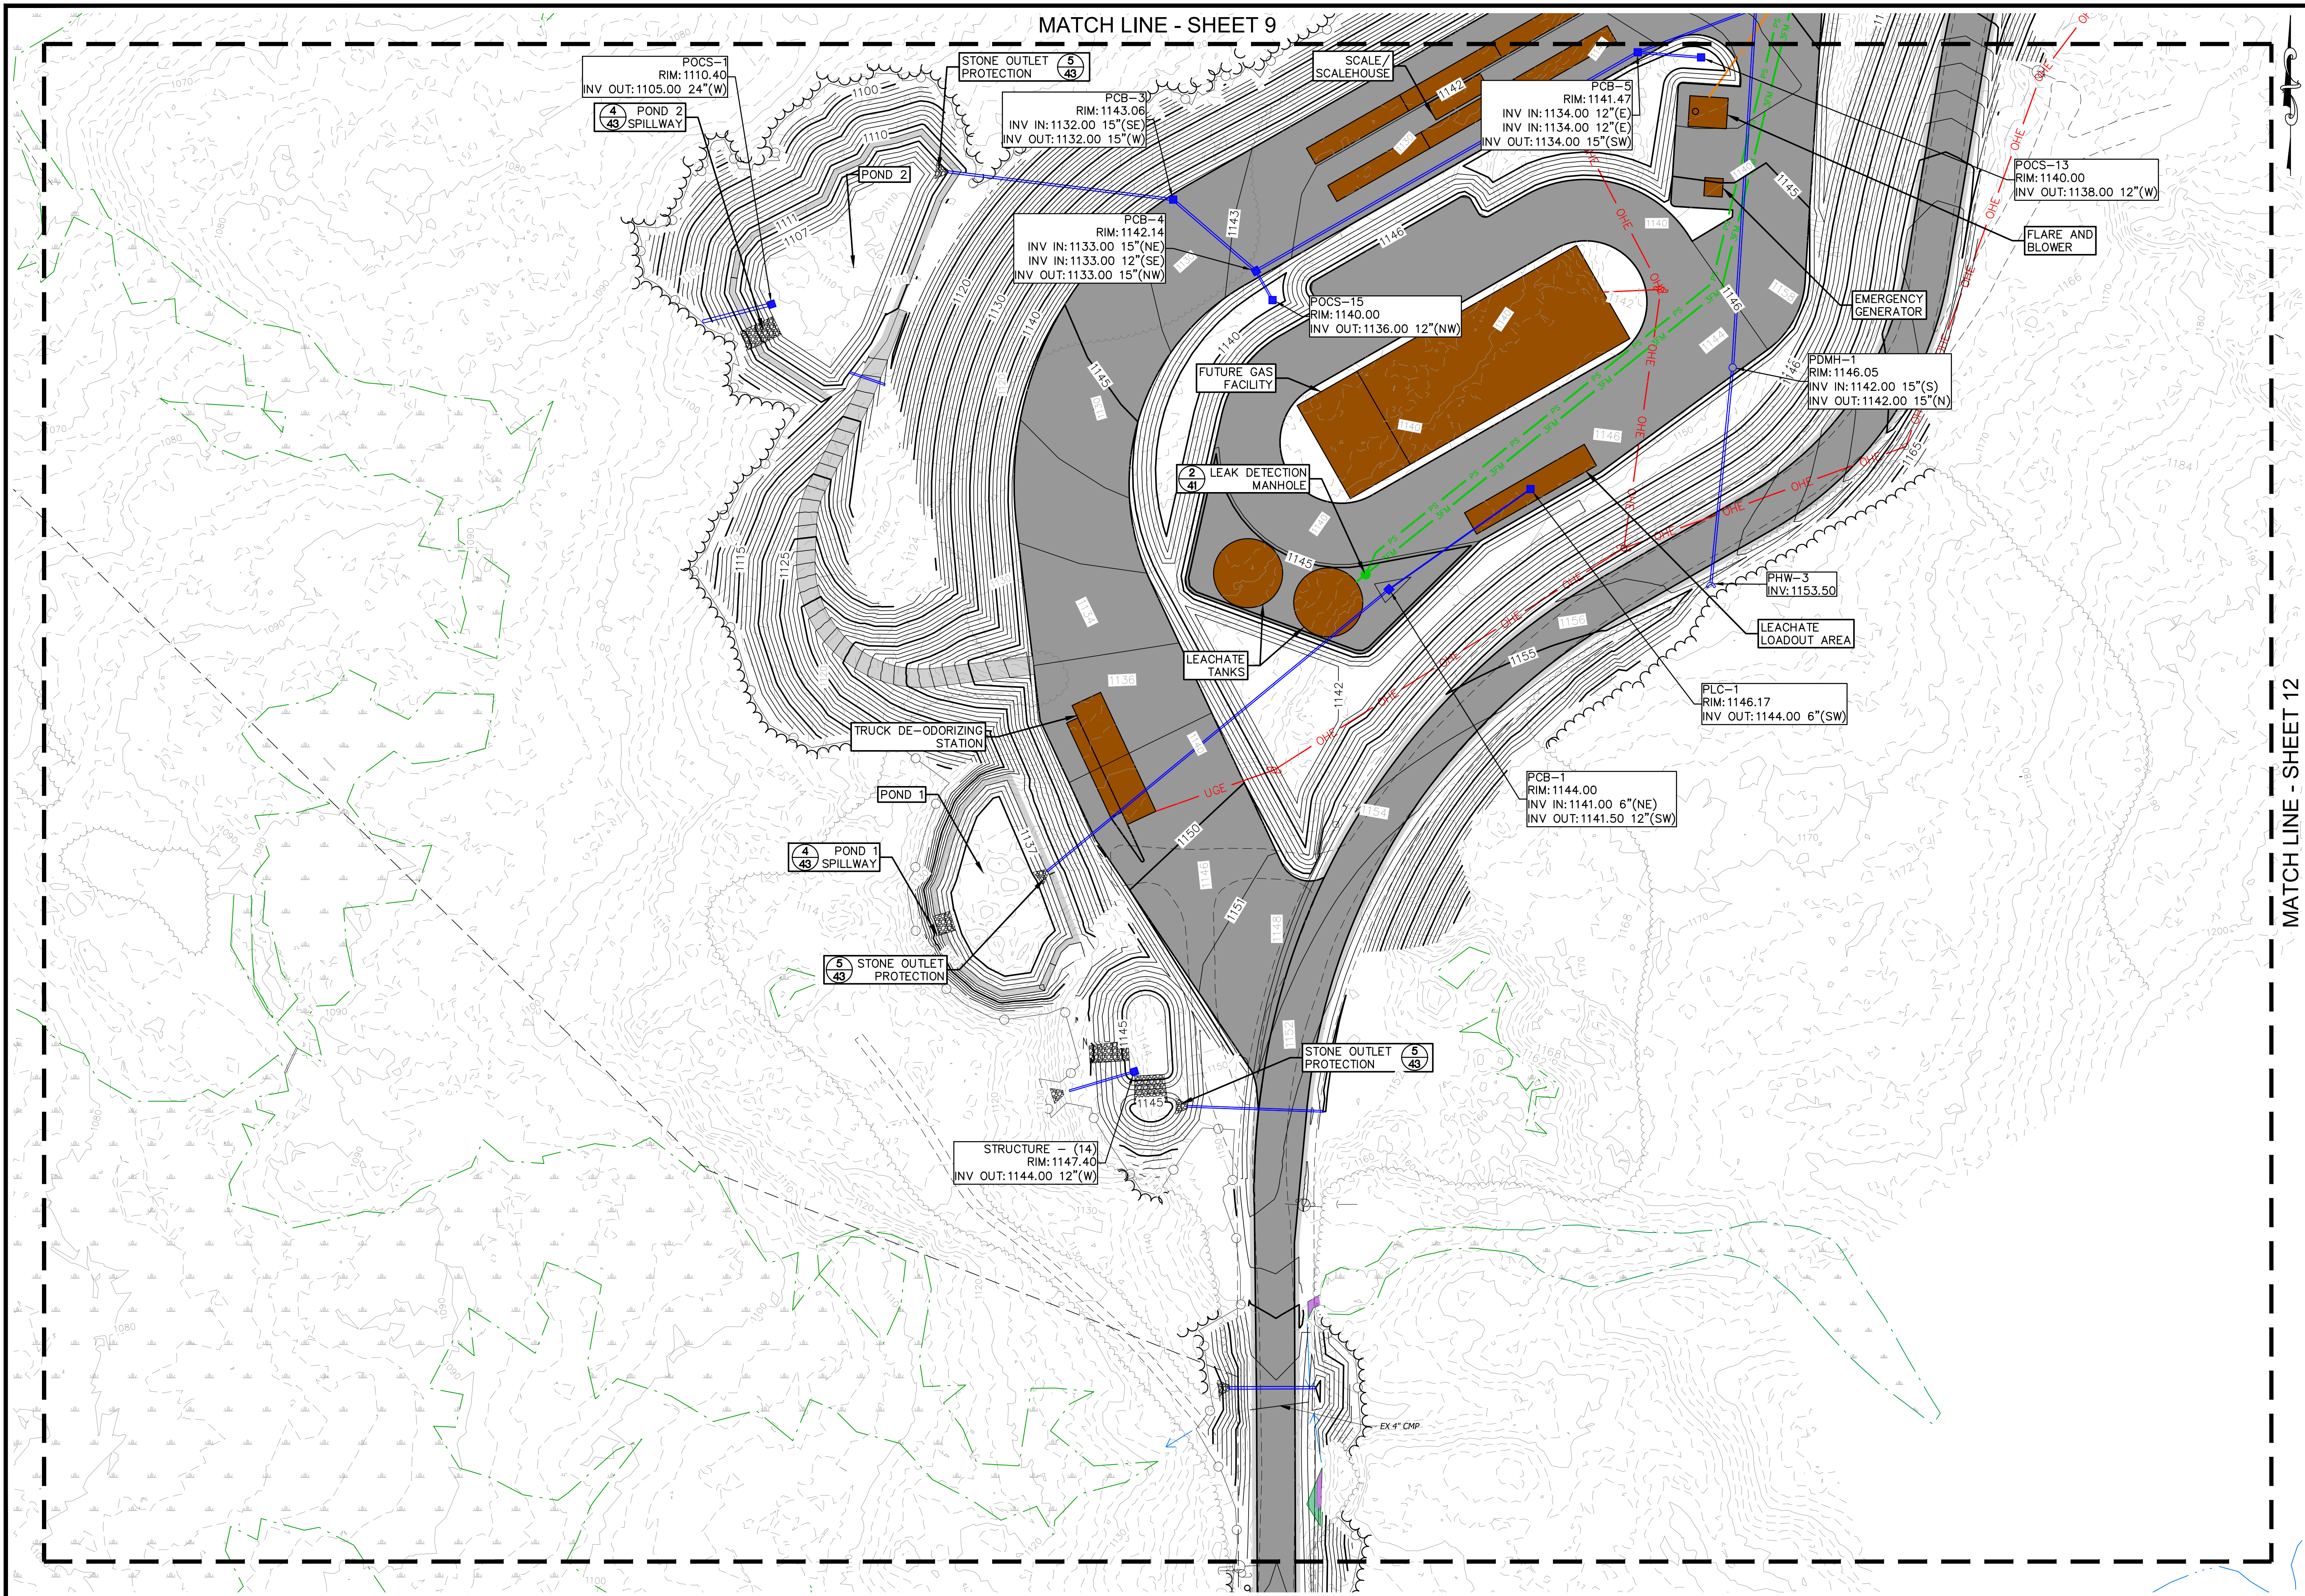

MATCH LINE - SHEET 12

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date: January 2024 project no: 1101	scale: 0 50' 100' Scale: 1" = 50'
Granite State Landfill, LLC Dalton, New Hampshire Permitting Plan Set	Grading & Drainage Plans Sheet 11
drawing no. Sheet 11	sheet: 12 of 12